




2 MODIFIED FLOOR PLAN
 A-1/A-1 SCALE: 1:100 M

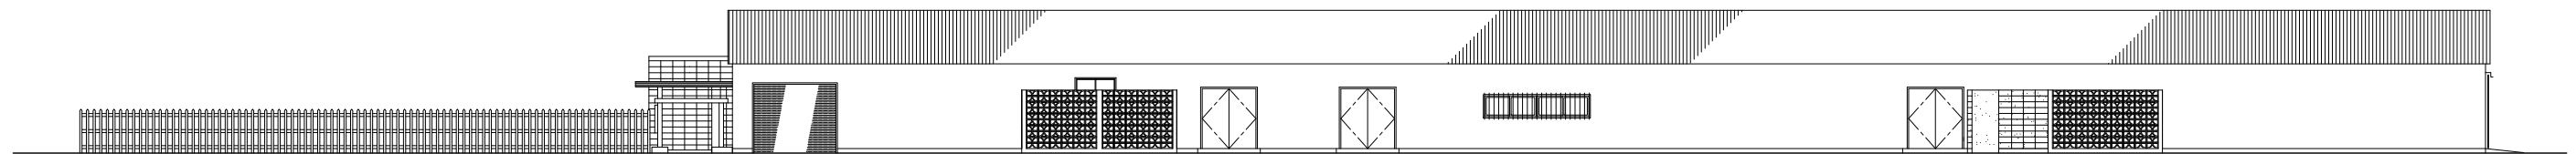

2 FRONT ELEVATION
 A-1/A-1 SCALE: 1:100 M

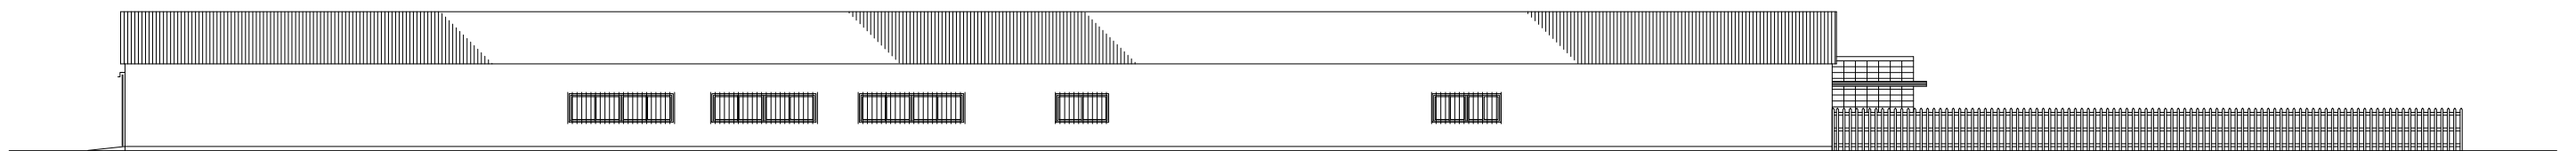

3 REAR ELEVATION
 A-1/A-1 SCALE: 1:100 M

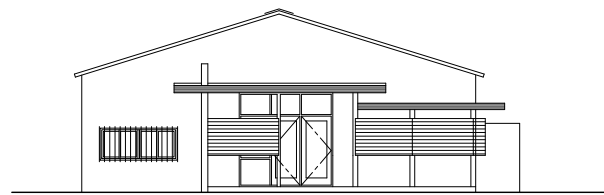

4 LEFT SIDE ELEVATION
 A-1/A-1 SCALE: 1:100 M

SCOPE OF WORK

REMOVAL WORKS

- ① REMOVE WOOD PARTITION ON WOOD STUDS.
- ② REMOVE WOOD DOOR AND FRAMES.
- ③ REMOVE ALUMINUM DOOR AND FRAMES.
- ④ REMOVE PORTION OF CMU TRASH ENCLOSURE.
- ⑤ OPEN UP EXISTING METAL SIDING FOR NEW EXTERIOR DOUBLE DOOR.

NEW WORKS

- ① PROVIDE SHEET VINYL FLOOR FINISH.
- ② PROVIDE VINYL COVE BASE.
- ③ PROVIDE ALUMINUM DOUBLE DOOR & FRAMES INCL HARDWARE.
- ④ REPAINT INTERIOR AND EXTERIOR (FRONT ONLY) OF THE BUILDING.
- ⑤ REPAIR CMU TRASH ENCLOSURE.
- ⑥ REFINISH EXISTING CONCRETE FLOOR PRIOR TO INSTALLATION OF NEW FLOOR FINISH.
- ⑦ PROVIDE CONCRETE STOOP.
- ⑧ PROVIDE RUBBER SEAL & CONCRETE SILL AT BOTTOM OF EXST ROLL-UP DOOR.
- ⑨ REINSTALL EXISTING WOOD PARTITION ON WOOD STUDS.
- ⑩ REINSTALL EXISTING WOOD DOOR AND FRAMES.
- ⑪ PROVIDE CONCRETE ENCASEMENT OF EXSITING STEEL COLUMNS AT ENTRY. (50 cm HIGH)

SYN		DESCRIPTION	DATE	APPROVAL
REVISIONS				
SUNABE CORPORATION 272 A2A-SUNABE, CHITAN-CHO OSAKA, JAPAN 564-02				
WAREHOUSE #1 ARCHITECTURAL FLOOR PLAN AND ELEVATIONS				
DRAWN BY E. MIYASONE	DESIGNER	CHECKER	DATE	SEC NO.
SUBMITTED BY			DATE	
FIRM MEMBER (TITLE)			DATE	
PROJECT ENGINEER			DATE	
UNIT CHIEF			DATE	
CHIEF, ENGR DESIGN			DATE	
DATE	26 DEC 2000	SCALE	AS SHOWN	SHEET 1 of 2